

## FILBY HALL, MAIN ROAD, FILBY, GT YARMOUTH, NORFOLK

## PROPOSED PLANS

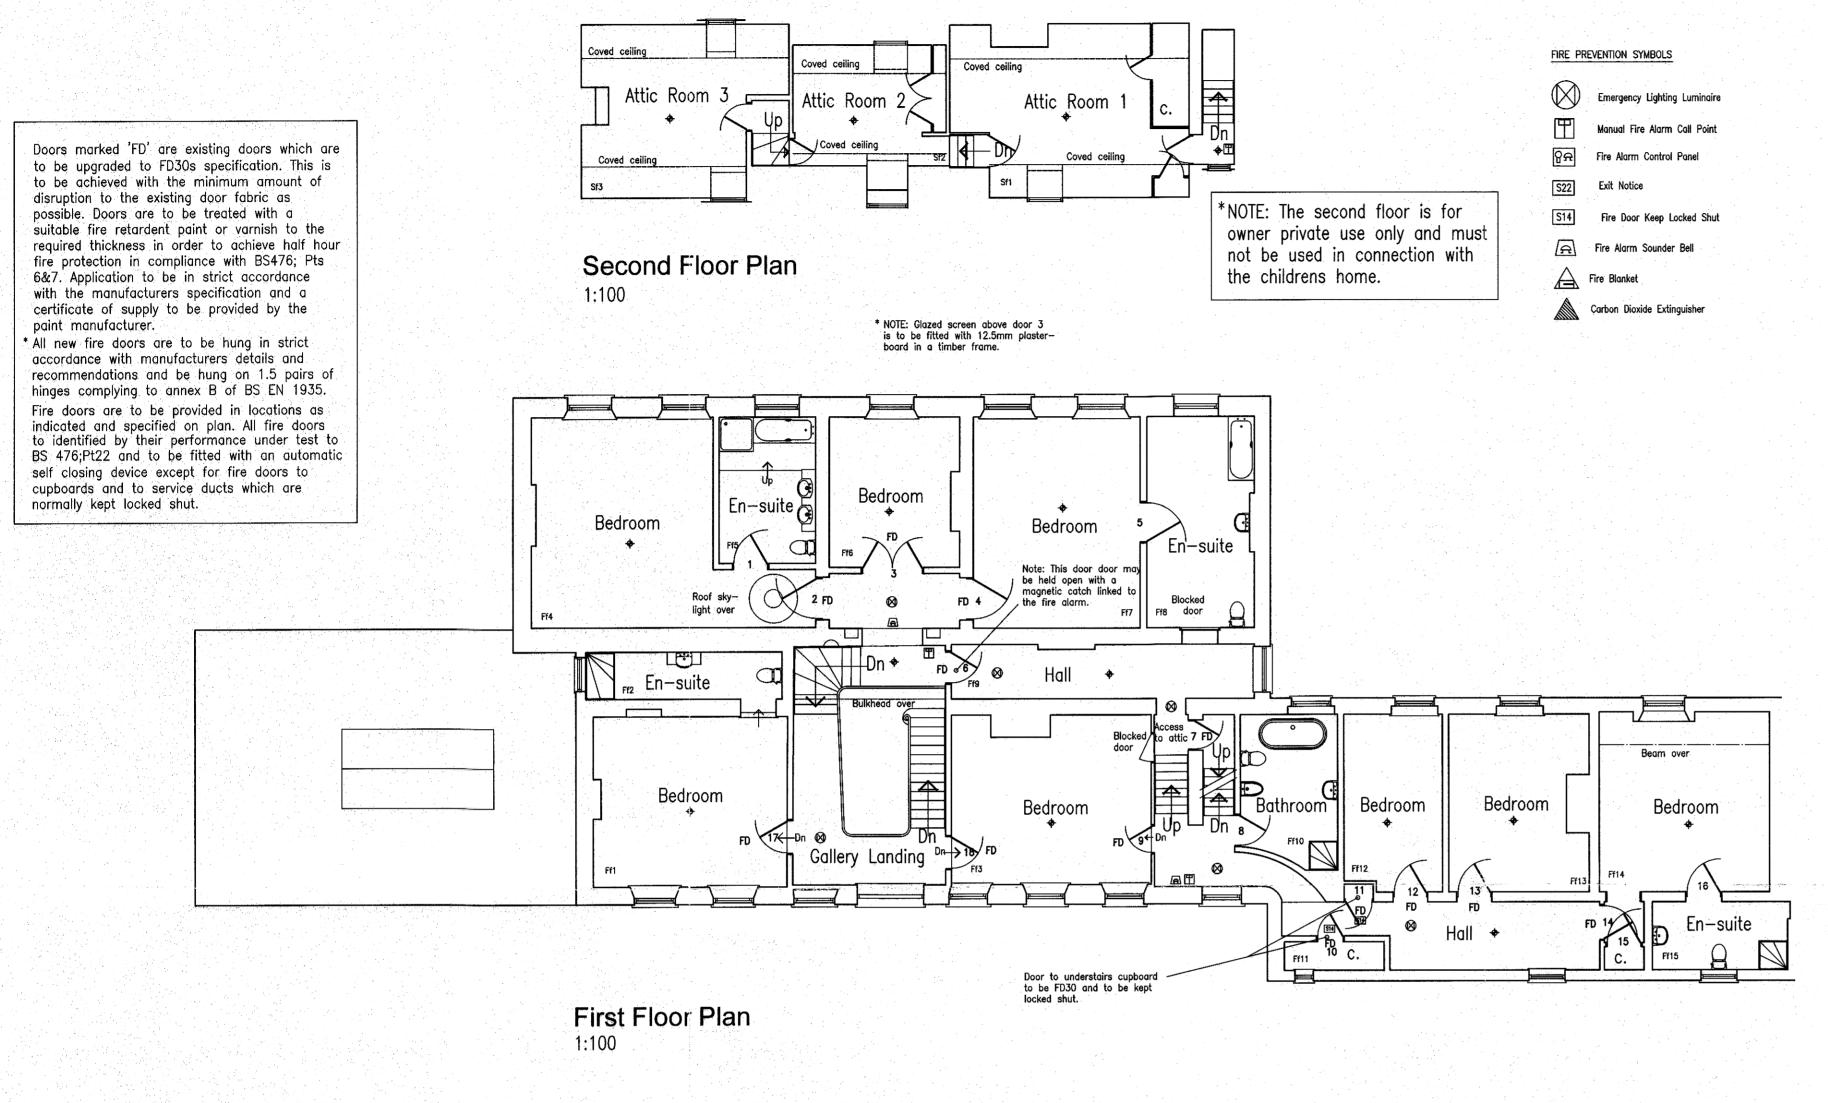

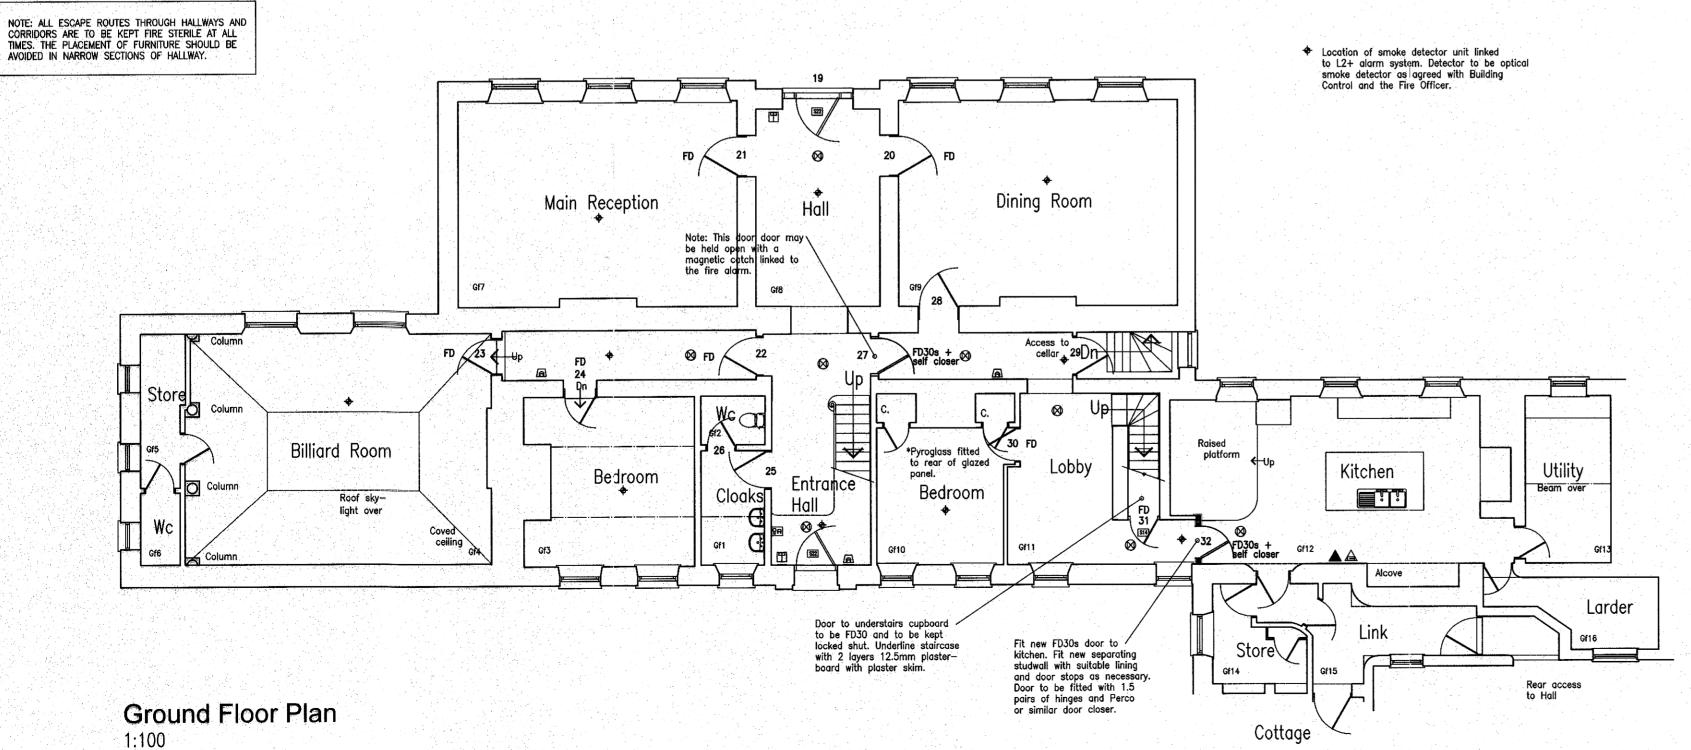

Emergency lighting to be installed in premises to fulfill the following functions:

a) To indicate clearly all the escape routes;
b) to provide illumination along such routes (including hazards such as stairs, ramps etc.) to allow safe movement towards, through and away from the exits provided;
c) to ensure that fire alarm call call points, fire

c) to ensure that fire alarm call call points, fire fighting equipment and exit signs provided along escape routes can be readily located. In addition to escape routes, the following areas should be provided with emergency lighting:

1) External areas in the immediate vicinity of exits;
2) control and plant rooms.

Emergency lighting to be either maintained or non maintained systems and to be installed in strict accordance with manufacturers details. System to comply with the recommendations of BS 5266: pt1;2005. Emergency lighting to illuminance along the centre line of the escape route of not less than 0.2lux and this level should be provided within 5 seconds of normal lighting failure. With the exception that in premises likely to be occupied for the most part by persons who are familiar with them, this period may be extended to 15 seconds.

Illuminated exit signs with normal and emergency electrical supply in locations as required by the Building Control Officer/Fire Officer.

FIRE ALARM SYSTEMS
The building to be provided with a suitable electrically operated fire warning system with manual call points sited adjacent to exit doors and sufficient sounders to be clearly audible throughout


An electrically operated fire alarm system should comply with the recommendations of BS 5839:Pt1;2002—Fire detection and alarm systems for buildings, Code of practice for system design, installation and servicing. BS5839:Pt1 specifies four types of system:

Type L— for the protection of life; subdivided into L1(systems installed throughout the protected building), L2(systems installed only in defined parts of the protected building) and L3(systems installed only for the protection of escape routes) NOTE: a type L2 system should normally include the coverage required of a type L3 system Type M— for manual alarm systems;


Type M— for manual alarm systems;
Type P— for property protection;
subdivided into P1(systems installed
throughout the protected building) and
P2(systems installed only in defined parts
of the protected building)
Type X— for multi occupancy buildings
Call points for electrical alarm systems
should comply with
BS5839:Pt2—Specification for manual call
points. Theses should be installed in

accordance with BS5839:Pt1.


NOTE: The Fire Alarm System specified for this building is an L2+ system which may be wireless. I should serve all areas of the building including loft spaces etc. as may be specified by the Fire Officer.

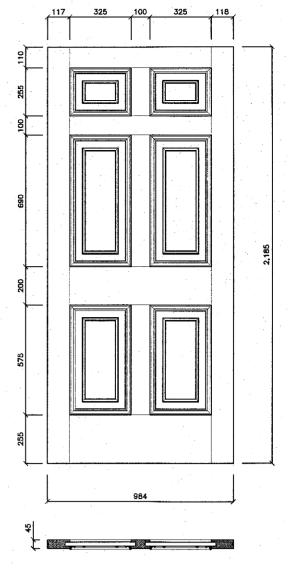




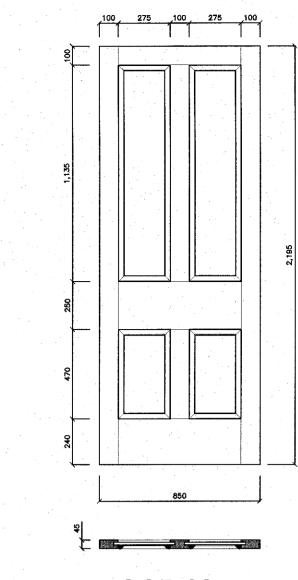

DOOR 32

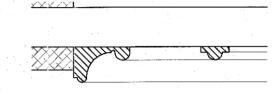

Detail of moulding to Door 22

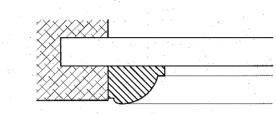

Detail of moulding to Door 32

	DOOR REF	LOCATION	REQUIRED SPECIFICATION	ALTERATIONS REQUIRED TO DOOR
	1	En-suite bathroom Ff5		No action required
	2	Bedroom Ff4	1/2 hour fire resisting with intumescent strip and self closer	Paint with approved paint system
	3	Bedroom Ff6	1/2 hour fire resisting with intumescent strip and self closer	Paint with approved paint system
-	4	Bedroom Ff7	1/2 hour fire resisting with intumescent strip and self closer	Paint with approved paint system
.  -	5	En-suite bathroom Ff8		No action required
	6	Hall/staircase Ff9	1/2 hour fire resisting with intumescent strip and self closer	Paint with approved paint system. Fit with magnetic catch linked to Fire Alarm
	7	Stairs to attic	1/2 hour fire resisting with intumescent strip and self closer	Paint with approved paint system
	8	Bathroom Ff10		No action required
	9	Bedroom Ff3	1/2 hour fire resisting with intumescent strip and self closer	Paint with approved paint system. Adjust door to fit frame at lhs.
	10	Cup/d Ff11	1/2 hour fire resisting with intumescent strip.	Paint with approved paint system
	- 11	Cup/d	1/2 hour fire resisting with intumescent strip	Paint with approved paint system or replace with fire resistant panel door.
	12	Bedroom Ff12	1/2 hour fire resisting with intumescent strip	Paint with approved paint system
	13	Bedroom Ff13	1/2 hour fire resisting with intumescent strip and self closer	Fit suitable handle. Adjustment to top lhs of door.
	14	Bedroom Ff14	1/2 hour fire resisting with intumescent strip and self closer	Paint with approved paint system
	15	Cup/d	1/2 hour fire resisting with intumescent strip	Paint with approved paint system or replace with fire resistant panel door.
	16	En-suite Ff15		No change
	17	Bedroom Ff1	1/2 hour fire resisting with intumescent strip and self closer	Paint with approved paint system. Adjustment to bottom lhs
	18	Bedroom Ff3	1/2 hour fire resisting with intumescent strip and self closer	Paint with approved paint system
	19	External door		No action required
	20	Dining Room Gf9	1/2 hour fire resisting with intumescent strip and self closer	Paint with approved paint system
	21	Main reception Gf7	1/2 hour fire resisting with intumescent strip and self closer	Paint with approved paint system
	22	Entrance hall	1/2 hour fire resisting with intumescent strip and self closer	New door to be fitted here (refer to drawing).
	23	Billiard Room Gf4		Paint with approved paint system
	24	Bedroom Gf3	1/2 hour fire resisting with intumescent strip and self closer	Paint with approved paint system
	25	Cloaks Gf1		No change
	26	Wc Gf2		No change
	27	Entrance hall	1/2 hour fire resisting with intumescent strip and self closer	Paint with approved paint system
	28	Dining Room Gf9	1/2 hour fire resisting with intumescent strip and self closer	Paint with approved paint system
	29	Cellar		No change
	30	Bedroom Gf10	1/2 hour fire resisting with intumescent strip and self closer	Glazed panel in door to have Pyroglass fitted to rear of door (refer to drawing). Adjustment to top lhs of door
	31	Cup/d Gf11	1/2 hour fire resisting with intumescent strip	Paint with approved paint system or replace with fire resistant panel door.
_	32	Kitchen Gf12	1/2 hour fire resisting with intumescent strip and self closer	New door to be fitted here (refer to drawing).

Form new lobby to separate basement from the remainder of the building. Build up 100mm x 50mm vertical studwork up off existing floor. Provide 50mm x 100mm timber soleplate and raise studs at 400mm centres. Face both sides with 2 layers 15mm plasterboard with plaster skim finish. Fit FD60s door with intumescent seals to perimeter. 25mm stops to door lining.

NOTE: partition is to be filled with 100mm Rockwool mineral fibre packed tightly into the partition to avoid any air gaps.

## Andrew Middleton 23 Regent Street

23, Regent Street Gt Yarmouth NORFOLK

NR30 1RL Tel. (01493) 858611

Project Filby

Filby Hall, Main Road, Filby, Gt Yarmouth, NORFOLK. Working drawings.

lient

Mr & Mrs Rapley

Scale 1:100

Date July 2012

Dwg no. 749/

Rev.A(Nov.'12)1/Building Reg. amendments. Rev.B(Jan.'13)1/Fire alarm system to be an L1 system.

## Basement Plan

store

Cold store

FIRE DOORS
Fire doors are to be provided in locations as indicated and specified on plan. All fire doors to identified by their performance under test to BS 476;Pt22 and to be fitted with an automatic self closing device except for fire doors to cupboards and to service ducts which are normally kept locked shut.

All new fire doors are to be hung in strict accordance with manufacturers details and

recommendations and be hung on 1.5 pairs of hinges complying to annex B of BS EN 1935.